

Unit 1 Metric Sizes

Ground Floor: 49.3 m2 1st Floor : 61.0 m2 Garage : 15.2 m2 : 3.6 m2 Balcony Unit 1 Total: 134.9 m2

Unit 2 Metric Sizes

Ground Floor: 49.3 m2 1st Floor : 61.0 m2 Garage : 15.2 m2 Balcony: 3.6 m²

Australian Design Services A Design World Of Difference

Unit 1 Feet & Inches

Ground Floor: 530 Sq. Ft 1st Floor : 656 Sq. Ft Garage : 163 Sq. Ft : 38 Sq. Ft Balcony

Unit 1 Total: 1452 Sq. Ft


Total Building 269.8 m²

Unit 1 Total: 134.9 m2


Unit 2 Feet & Inches

Ground Floor: 530 Sq. Ft 1st Floor : 656 Sq. Ft : 163 Sq. Ft Garage Balcony : 38 Sq. Ft Unit 1 Total: 1452 Sq. Ft

Total Building 2904 Sq Ft

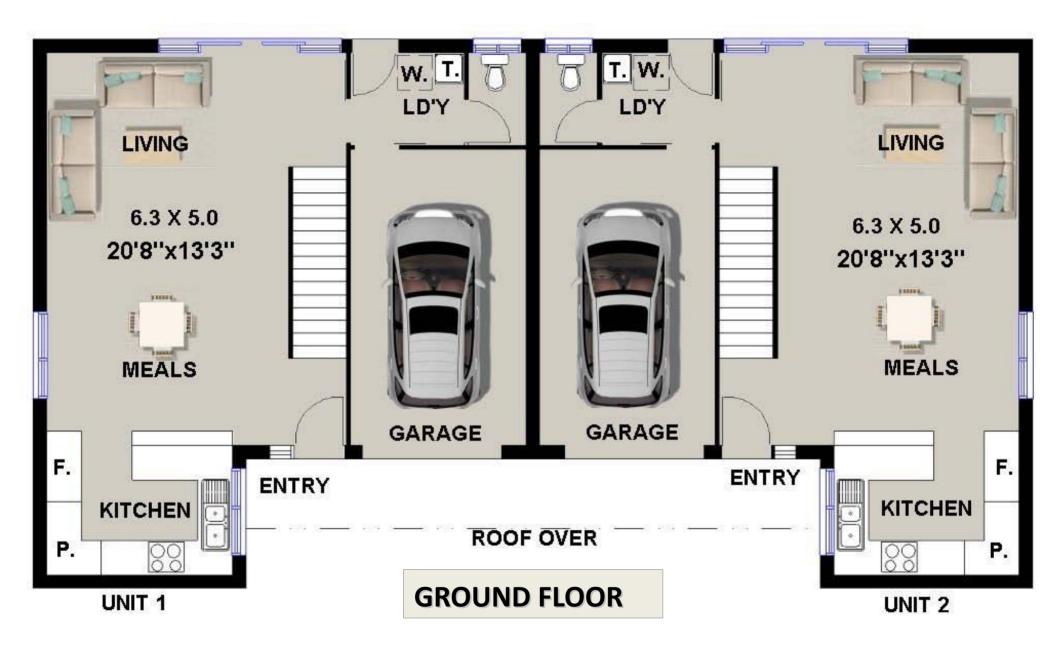

Duplex House Design: 269DU 6 Bedroom + 2 Study Nooks + 4 Bathroom + 2 Car

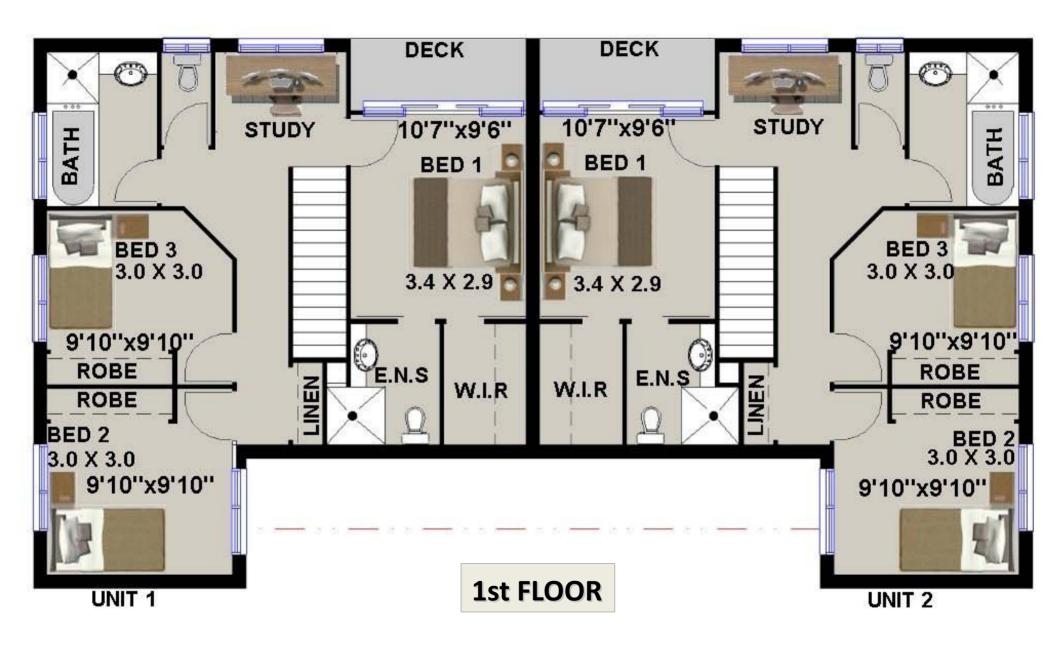



Ground Floor: 530 Sq. Ft 1st Floor : 656 Sa. Ft : 163 Sq. Ft Garage

Balconv : 38 Sq. Ft Unit 1 Total: 1452 Sq. Ft

Unit 1 Feet & Inches

Ground Floor: 530 Sq. Ft 1st Floor : 656 Sq. Ft Garage : 163 Sq. Ft Balcony : 38 Sq. Ft

Unit 2 Feet & Inches

Total Building 2904 Sq Ft

Unit 1 Total: 1452 Sq. Ft

Width Feet 54'2" x 29'8"

Unit 1 Metric Sizes

Ground Floor: 49.3 m2 1st Floor : 61.0 m2

Garage : 15.2 m2

Balconv : 3.6 m2


Unit 1 Total: 134.9 m2

Unit 2 Metric Sizes

Ground Floor: 49.3 m2 1st Floor : 61.0 m2 : 15.2 m2 Garage Balconv : 3.6 m2

Unit 1 Total: 134.9 m2


Total Building 269.8 m2

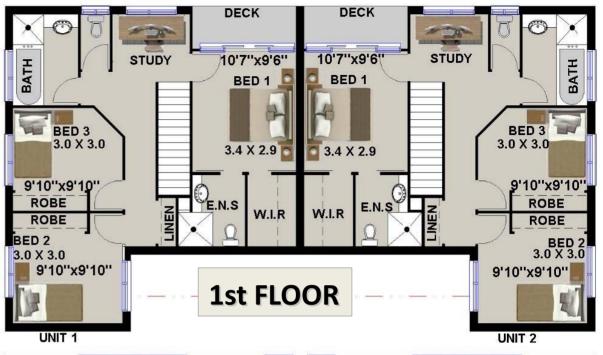





Width 16.52 x 9.04 Meters

GROUND FLOOR PLAN FEET & INCHES

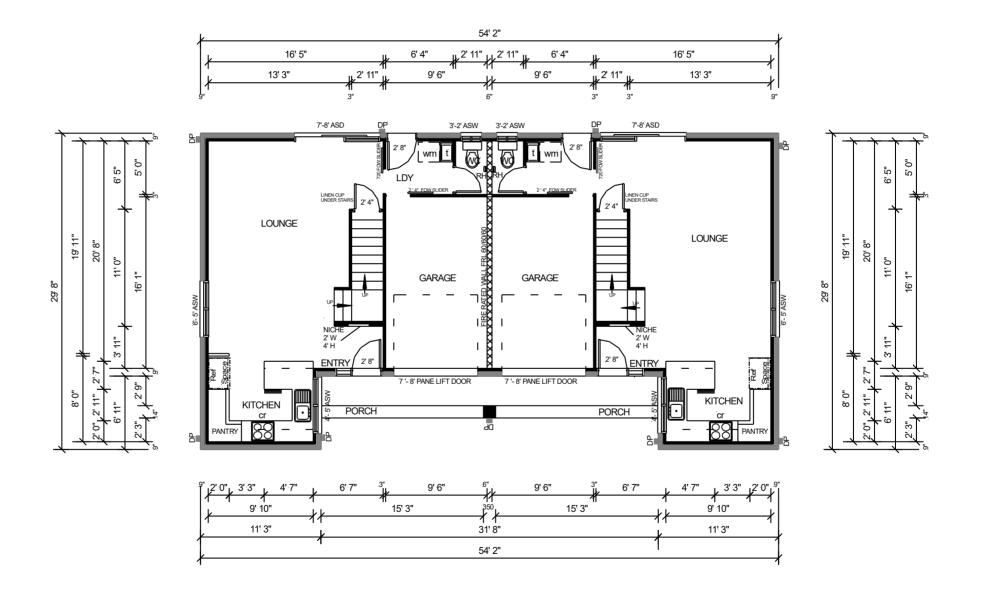

1ST FLOOR PLAN FEET & INCHES

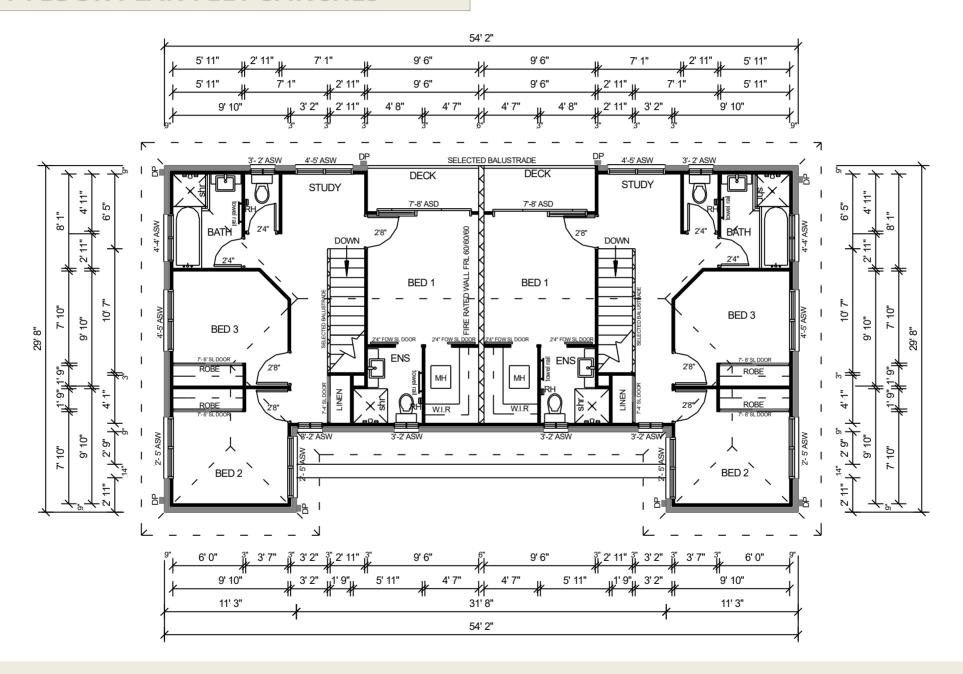

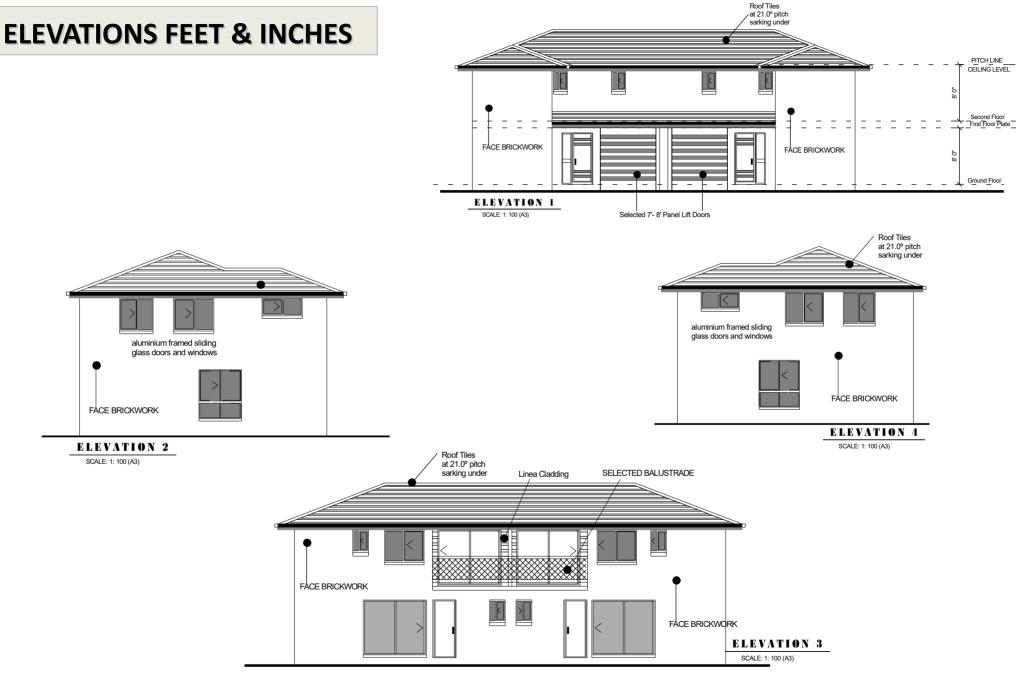

CONSTRUCTION NOTES

- 1. EXTERNAL WALLS = 9" INTERNAL WALLS = 3"
- 2. N2 WIND DESIGN SPEED
- 3. ALL INTERNAL DOORS 7'
- 4. WC DOOR TO HAVE EXTERNAL REMOVABLE HINGES IN ACCORDANCE WITH BCA-3.8.3.3

ENERGY EFFICIENCY NOTES:

- 1. ALL SHWER ROSES TO BE 'AAA' SHOWER ROSES
- 2. IF WATER PRESSURE TO BUILDING EXCEEDS 500 kpa PRESSURE LIMITING DEVICE TO BE INSTALLED.
- 3. MINIMW 4-STAR WELS RATED TOILETS TO BE INSTALLED.
- 4. MINIMW 3-STAR WELS RATED TAP'WARE FOR
- 5. KITCHEN SINKS, BATHROOM BASINS & LAUNDRY TROUOHS.
- 6. 60 GALLONS HOT WATER SYSTEM
- 7. MINIMUM 4-STAR MEPS RATED AIR CONDITIONERS TO BE INSTALLED (IF APPLICABLE)
- 8. 80% TOTAL ENCLOSED FLOOR AREA TO HAVE ENERGY EFFICIENT GLOBES INSTALLED.
- 9. INSULATION ABOVE 3.3 R VALUE TO ALL CEILING SPACE INCLUDING TERRACE & FRONT BALCONY

LEGEND CONSTRUCTION JOINT **DOWNPIPE** FP FIRE PLACE FW FLOOR WASTE **EPS** EXPANDED POLYSTYRENE FOAM (EPS) Sandwiched HWS HOT WATER SYSTEM AC PS SP AIR CONDITIONING PLUMBING STACK / DUCT STEEL POST T.B.C. TO BE CONFIRMED RL AHD RELATIVE LEVEL AUSTRALIAN HEIGHT DATUM CSD OHC FG CAVITY SLIDING DOOR OVER HEAD CUPBOARD FIXED GLASS FSR FLOOR SPACE RATIO LOAD BEARING LB NATURAL GROUND LINE NGL UBO UNDER BENCH OVEN WO WALL OVEN DW DISHWASHER MW MICROWAVE WM WASHING MACHINE WIR WALK-IN-ROBE ASD SLIDING GLASS DOOR ASW ALUMINIUM SLIDING WINDOW

ALUM. DOUBLE HUNG WINDOW


ALUM. AWNING WINDOW


ALUM. LOUVRE WINDOW BUILDING CODE OF AUSTRALIA AUSTRALIAN STANDARDS


ADH

AAW

ALW

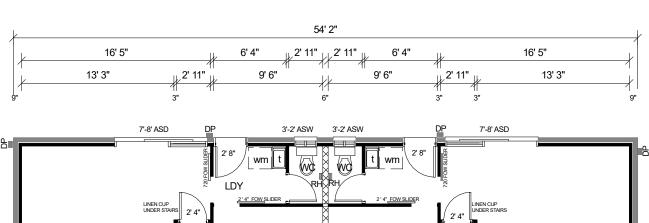

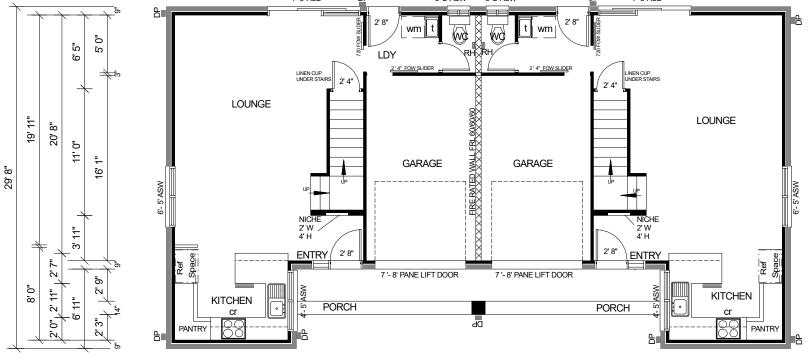

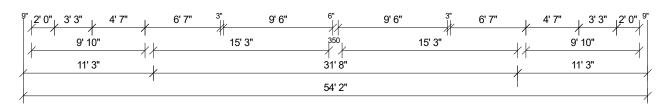



DATE:	SCALE: 1:100			
CLIENT:		UNIT 1:	UNIT 2:	DRAWN: BUILDER-DESIGNER:
SITE:	Ground F	loor 530 Sq. FT	530 Sq. FT	
SITE.	1st Floor	656 Sq. FT	656 Sq. FT	1
	Garage	163. Sq. FT	163. Sq. FT	
	_Deck	38 Sq. FT	38 Sq. FT]
	Sub-Tota	1452 Sq. FT	1452 Sq. FT	
DO NOT SCALE OFF. Written dimensions take precedence	Total	2904	Sq. FT	WIND SPEED: N2

GROUND FLOOR PLAN

General notes:

- concrete construction to comply with USA Building Regulations
- timber frame construction to comply with USA Building Regulations
 metal roofing to comply with USA Building Regulations

6'5"

19

29'

20'

^{2'}'

.'0", 2' 11"

<u>_</u>

8'0"

- metal rouling to corripply with 193A building Regulations wet areas to comply with the provisions of Part 3.8.1of the USA.


 weepholes in masonry walls at 3' ctrs.

 glass installation to comply with USA Building Regulations.

 s denotes smoke detector; smoke alarms to comply USA Building Regulations.

 glass installation to comply with USA Building Regulations.

 protection of masonry walls used to use the complete size of the complete with the provisions of Part 3.7.2 of the USA Building Regulations. - manhole position approx. only, determine on site.
- provide alcor barrier between lead flashing and zincalume valley gutter as required.
 - keep hws 4" clear of walls.
 - protection of masonry wall ties to comply with the
 - USA Building Regulations.
 protection of lintels in masonry to comply with the
 - mechanical ventilation to internal wc to be vente to external air via ducting in accordance with USA Building Regulations

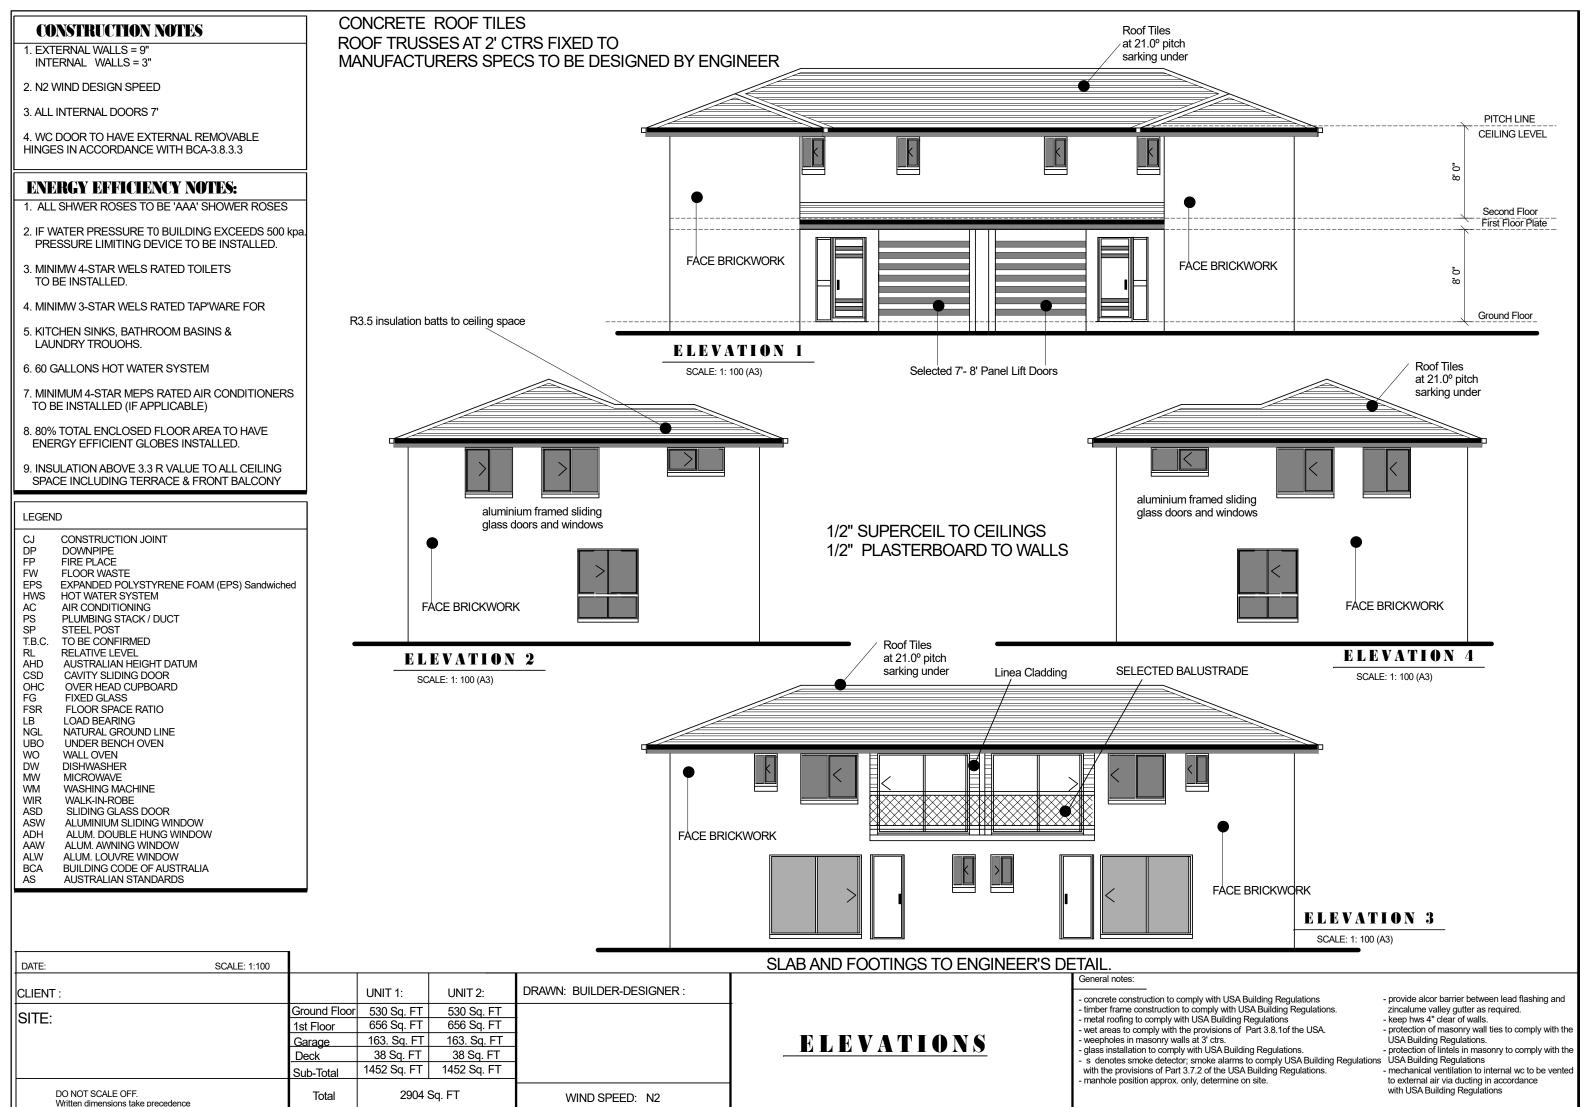


CONSTRUCTION NOTES


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- 2. N2 WIND DESIGN SPEED
- 3. ALL INTERNAL DOORS 7'
- 4. WC DOOR TO HAVE EXTERNAL REMOVABLE HINGES IN ACCORDANCE WITH BCA-3.8.3.3

ENERGY EFFICIENCY NOTES:

- 1. ALL SHWER ROSES TO BE 'AAA' SHOWER ROSES
- 2. IF WATER PRESSURE TO BUILDING EXCEEDS 500 kpa PRESSURE LIMITING DEVICE TO BE INSTALLED.
- 3. MINIMW 4-STAR WELS RATED TOILETS TO BE INSTALLED.
- 4. MINIMW 3-STAR WELS RATED TAP'WARE FOR
- 5. KITCHEN SINKS, BATHROOM BASINS & LAUNDRY TROUOHS.
- 6. 60 GALLONS HOT WATER SYSTEM
- 7. MINIMUM 4-STAR MEPS RATED AIR CONDITIONERS TO BE INSTALLED (IF APPLICABLE)
- 8. 80% TOTAL ENCLOSED FLOOR AREA TO HAVE ENERGY EFFICIENT GLOBES INSTALLED.
- 9. INSULATION ABOVE 3.3 R VALUE TO ALL CEILING SPACE INCLUDING TERRACE & FRONT BALCONY

LEGEND CONSTRUCTION JOINT **DOWNPIPE** FP FIRE PLACE FW FLOOR WASTE **EPS** EXPANDED POLYSTYRENE FOAM (EPS) Sandwiched HWS HOT WATER SYSTEM AC PS SP AIR CONDITIONING PLUMBING STACK / DUCT STEEL POST T.B.C. TO BE CONFIRMED RL AHD RELATIVE LEVEL AUSTRALIAN HEIGHT DATUM CAVITY SLIDING DOOR CSD OHC FG OVER HEAD CUPBOARD FIXED GLASS FSR FLOOR SPACE RATIO LOAD BEARING LB NGL NATURAL GROUND LINE UBO UNDER BENCH OVEN WO WALL OVEN DW DISHWASHER MW MICROWAVE WM WASHING MACHINE WIR WALK-IN-ROBE ASD SLIDING GLASS DOOR ASW ALUMINIUM SLIDING WINDOW ADH ALUM. DOUBLE HUNG WINDOW AAW ALUM. AWNING WINDOW ALW ALUM. LOUVRE WINDOW BUILDING CODE OF AUSTRALIA AUSTRALIAN STANDARDS

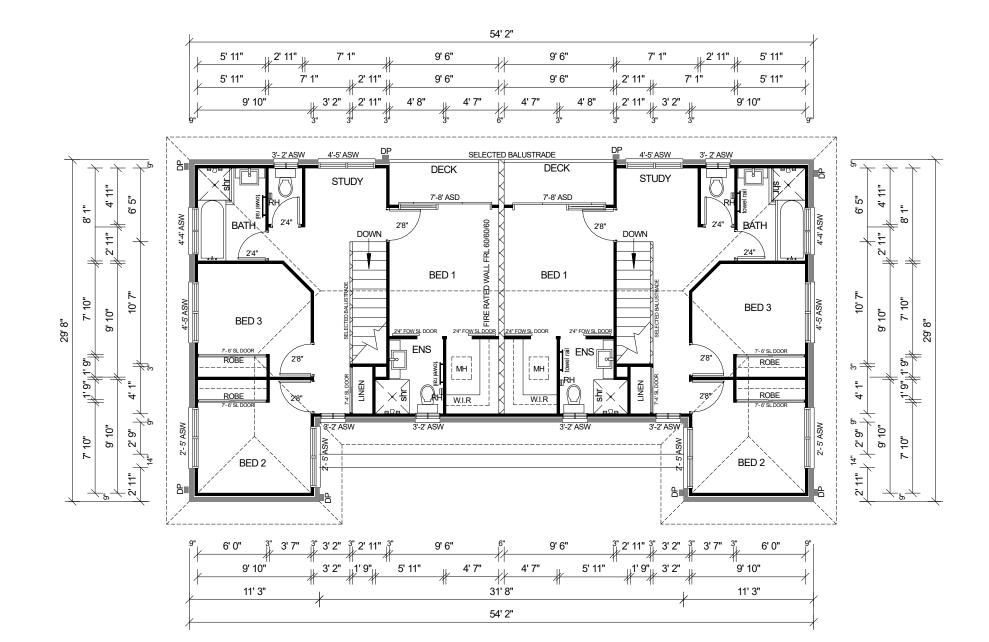

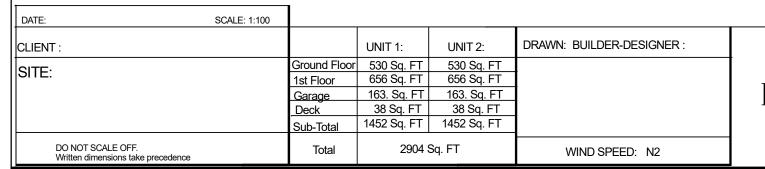

FIRST FLOOR

General notes:

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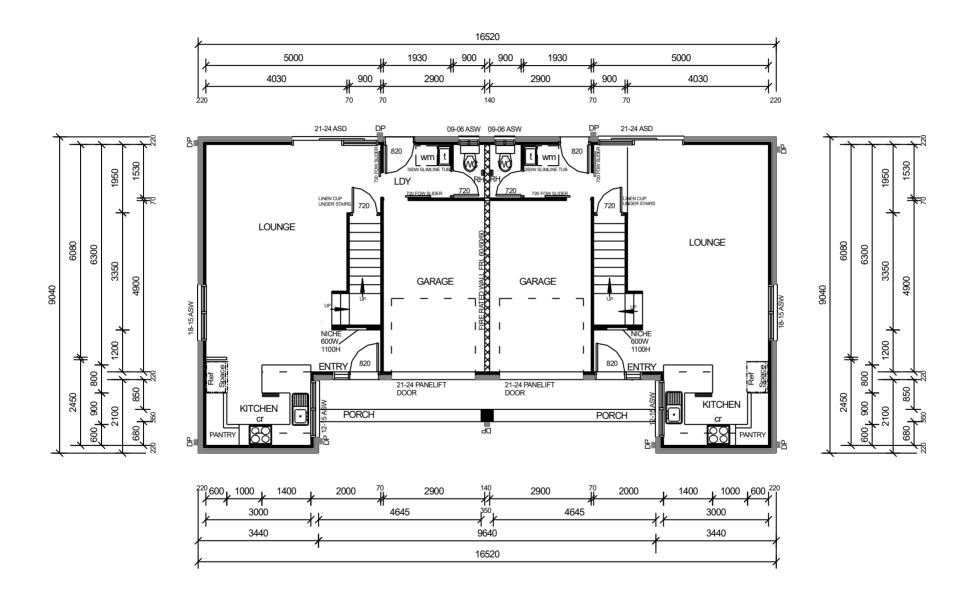
 glass installation to comply with USA Building Regulations.

 s denotes smoke detector; smoke alarms to comply USA Building Regulations.


 glass installation to comply with USA Building Regulations.

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 protection of lintels in masonry to comply with the
 - mechanical ventilation to internal wc to be vente to external air via ducting in accordance with USA Building Regulations

GROUND FLOOR PLAN METRIC



1ST FLOOR PLAN METRIC

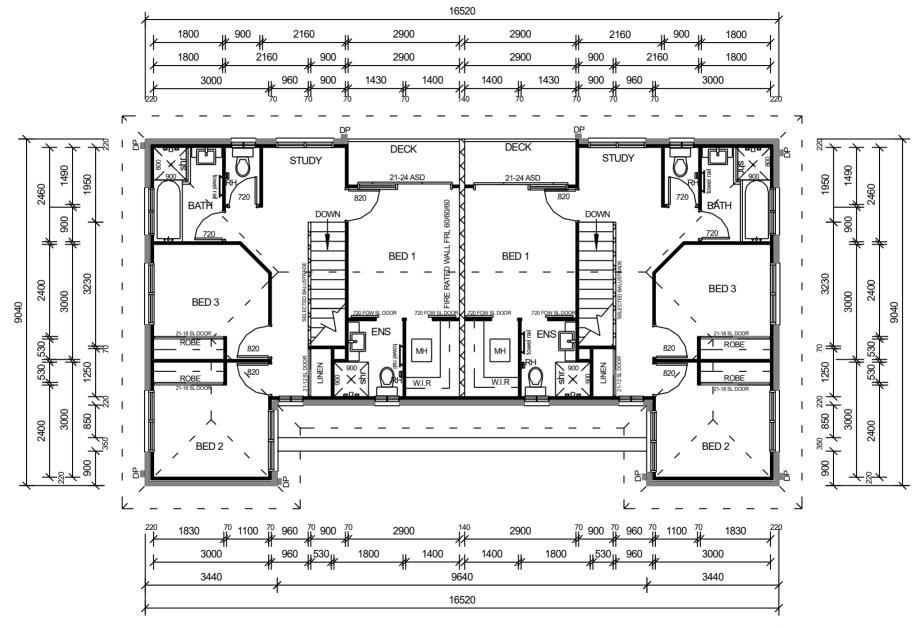

Duplex House Design: 269DU 6 Bedroom + 2 Study Nooks + 4 Bathroom + 2 Car **ELEVATIONS METRIC** Roof Tiles at 21.0° pitch sarking under PITCH LINE CEILING LEVEL Second Floor First Floor Plate FACE BRICKWORK EACE BRICKWORK Ground Floor ELEVATION 1 SCALE: 1: 100 (A3) Selected 21-24 Panel Lift Doors Roof Tiles at 21.0° pitch sarking under aluminium framed sliding glass doors and windows aluminium framed sliding glass doors and windows FACE BRICKWORK FACE BRICKWORK **ELEVATION 4 ELEVATION 2** SCALE: 1: 100 (A3) SCALE: 1: 100 (A3) Roof Tiles at 21.0° pitch Linea Cladding SELECTED BALUSTRADE FACE BRICKWORK FACE BRICKWORK **ELEVATION 3** SCALE: 1: 100 (A3)

CONCEPT & PERMIT PLANS


CONSTRUCTION NOTES


- 1. EXTERNAL WALLS = 220 mm 70mm wall + 40mm cavity + 110 Bricks (unless otherwise nominated)
- 2. N2 WIND DESIGN SPEED
- 3. ALL INTERNAL DOORS 2040 HT
- 4. WC DOOR TO HAVE EXTERNAL REMOVABLE HINGES IN ACCORDANCE WITH BCA-3.8.3.3


ENERGY EFFICIENCY NOTES:


- 1. ALL SHOWER ROSES TO BE 'AAA' SHOWER ROSES
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- 3. MINIMW 4-STAR WELLS RATED TOILETS TO BE INSTALLED.
- 4. MINIMW 4-STAR WELLS RATED TAP'WARE FOR
- 5. KITCHEN SINKS, BATHROOM BASINS & LAUNDRY TROUGHS.
- 6. 250 LITRE RHEEM HOT WATER SYSTEM (OR SIMILAR)
- 7. MINIMUM 4-STAR MEPS RATED AIR CONDITIONERS TO BE INSTALLED (IF APPLICABLE)
- $8.\,80\%$ TOTAL ENCLOSED FLOOR AREA TO HAVE ENERGY EFFICIENT GLOBES INSTALLED.
- 9. R1.5 WALL INSULATION R5.0 CEILING INSULATION
- 10. RAINWATER WATER TANK 2000 LITRE MIN.

LEGEN	ID
CJ DP FP FW EPS HWS AC PS SP T.B.C. RL CSD OHC FG FSR LB NGL UBO	CONSTRUCTION JOINT DOWNPIPE FIRE PLACE FLOOR WASTE EXPANDED POLYSTYRENE FOAM (EPS) Sandwiched HOT WATER SYSTEM AIR CONDITIONING PLUMBING STACK / DUCT STEEL POST TO BE CONFIRMED RELATIVE LEVEL AUSTRALIAN HEIGHT DATUM CAVITY SLIDING DOOR OVER HEAD CUPBOARD FIXED GLASS FLOOR SPACE RATIO LOAD BEARING NATURAL GROUND LINE UNDER BENCH OVEN
UBO	UNDER BENCH OVEN
WO	WALL OVEN
DW	DISHWASHER
MW	MICROWAVE
WM	WASHING MACHINE
WIR	WALK-IN-ROBE
ASD	SLIDING GLASS DOOR
ASW	ALUMINIUM SLIDING WINDOW
ADH	ALUM. DOUBLE HUNG WINDOW
AAW	ALUM. AWNING WINDOW
ALW	ALUM. LOUVRE WINDOW
BCA	BUILDING CODE OF AUSTRALIA
AS	AUSTRALIAN STANDARDS

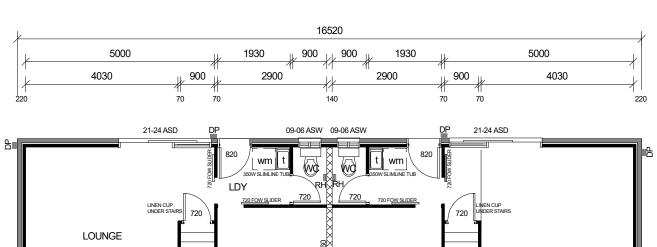

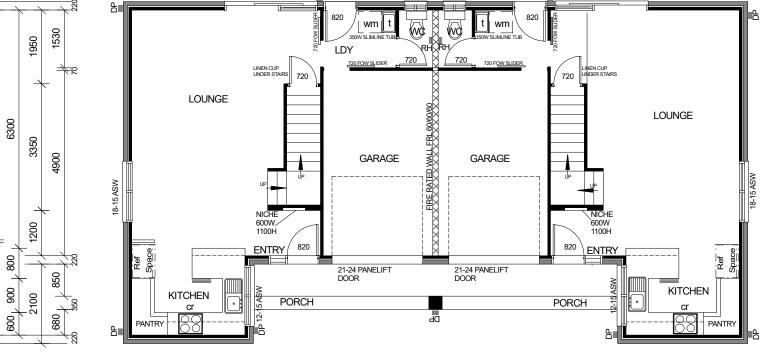

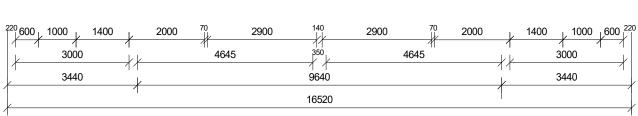

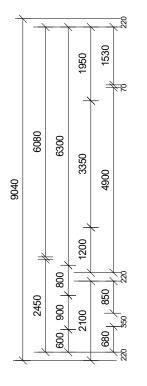




DATE: SCALE: 1:10	00			1
CLIENT :		UNIT 1:	UNIT 2:	DRAWN: BUILDER-DESIGNER:
SITE:	Ground Floor	49.3 m²	49.3 m²	
SITE.	1st Floor	61.0 m ²	61.0 m ²	
	Garage	15.2 m²	15.2 m ²	
	Deck	3.6 m ²	3.6 m ²	
	Sub-Total	134.9 m²	134.9 m²	_
DO NOT SCALE OFF. Written dimensions take precedence	Total	269.8 m²		WIND SPEED: N2

6080

GROUND FLOOR PLAN

- concrete construction to comply with AS2870 AND AS3600 BCA
- timber frame construction to comply with AS1684 -2006.
 roof tiles roofing to comply with AS1757 /AS2050
 wet areas to comply with the provisions of Part 3.8.10f the bca.
- weepholes in masonry walls at 900 ctrs.
- glass installation to comply with AS1288 and AS2047.
- s denotes smoke detector; smoke alarms to comply
- with the provisions of Part 3.7.2 of the BCA.
- manhole position approx. only, determine on site.

- provide alcor barrier between lead flashing and
- zincalume valley gutter as required.
- keep hws 100 clear of walls.
 protection of masonry wall ties to comply with the provisions of Part 3.3.3.2 of the BCA.
- protection of lintels in masonry to comply with the provisions of Part 3.3.3.4 of the BCA.
- mechanical ventilation to internal wc to be vented to external air via ducting in accordance with the provisions of part 3.8.5.0 of the BCA 1996.

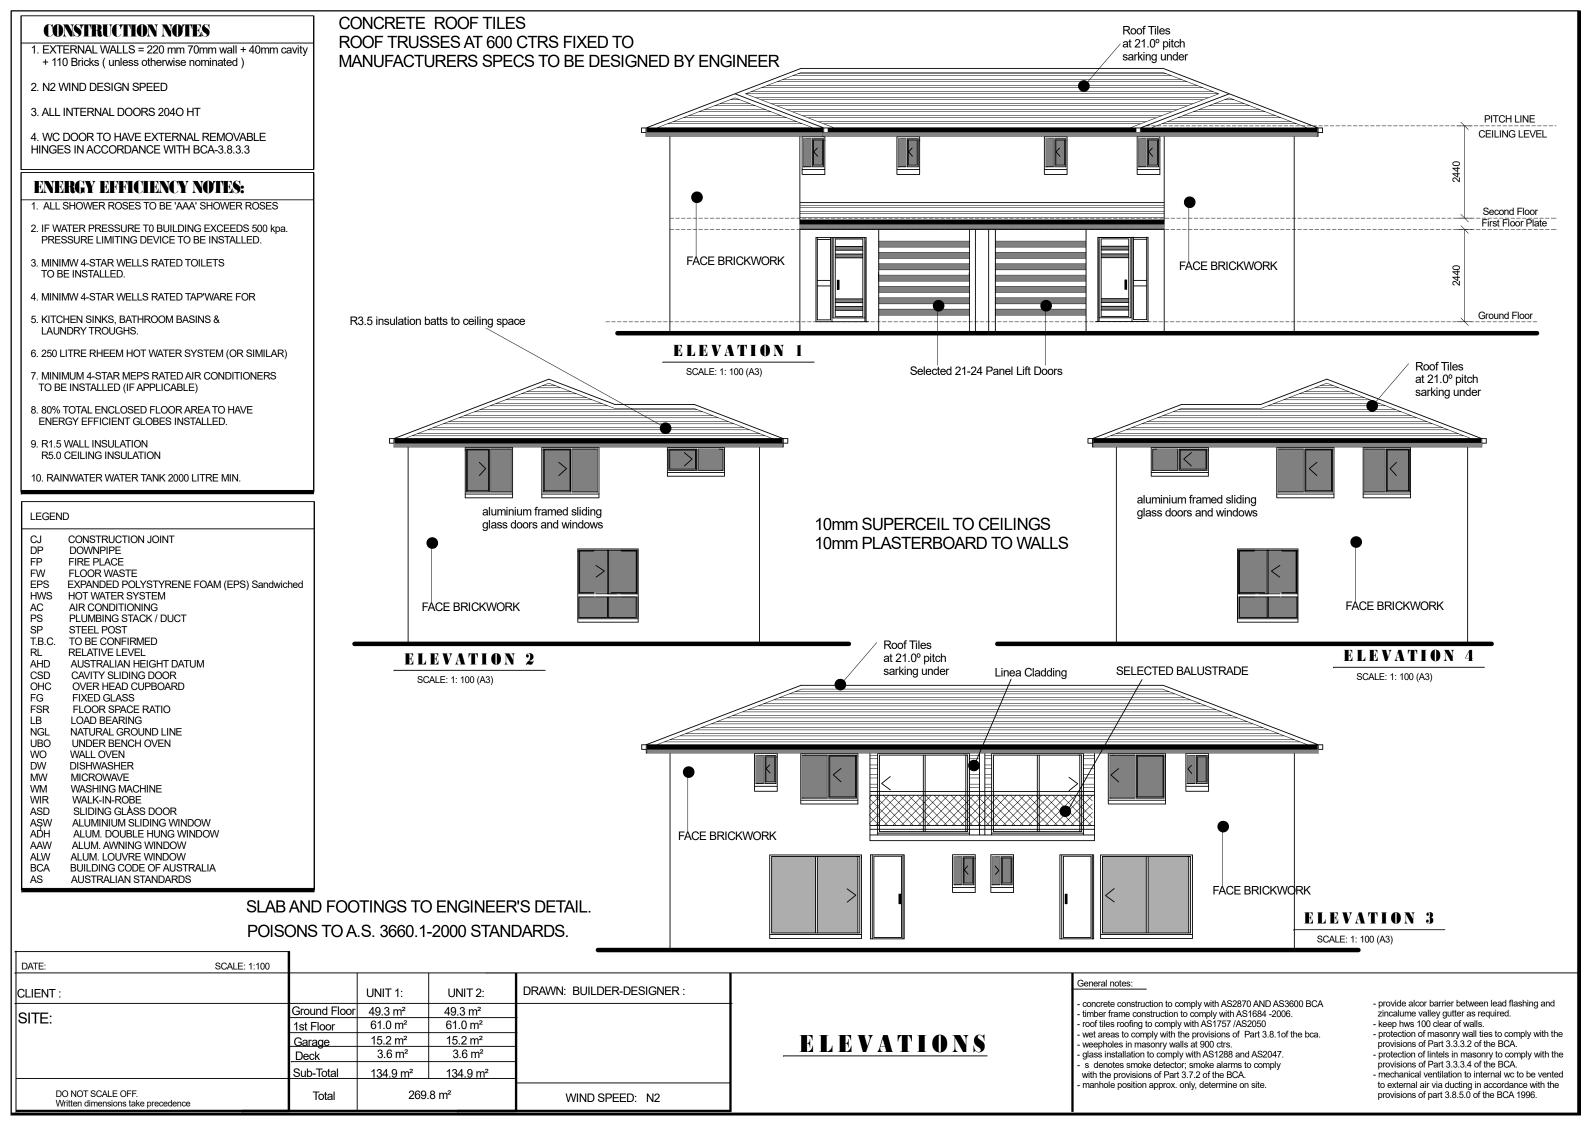


CONSTRUCTION NOTES


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LEGEND				
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NGL UBO WO DW	NATURAL GROUND LINE UNDER BENCH OVEN WALL OVEN DISHWASHER			
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FIRST FLOOR

- concrete construction to comply with AS2870 AND AS3600 BCA

- controlle construction to comply with AS2670 AND AS3600 BCA timber frame construction to comply with AS1684 -2006.

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- mechanical ventilation to internal wc to be vented to external air via ducting in accordance with the provisions of part 3.8.5.0 of the BCA 1996.

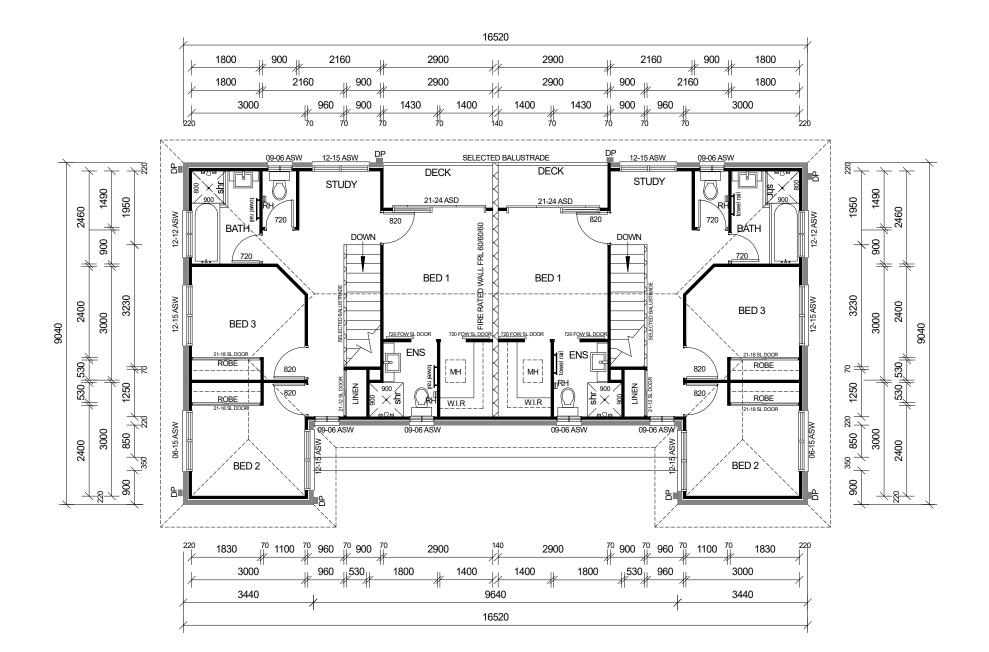CONCEPT PLANS

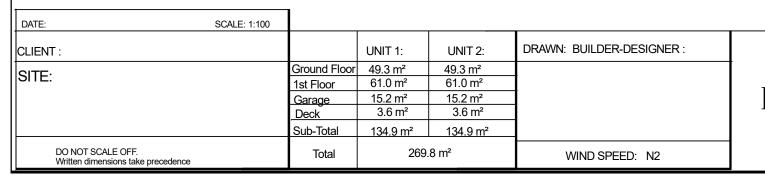About Our Concept Home Plans

Our concept house plans are a great and smart way to develop a range of homes at a fraction of the costs of developing your own range.

These floor plans were created as preliminary house plans for previous clients or new concepts by the designer.

Choose a plan and tweak it to your lifestyle or have us complete the plans as is. As an option, you can have your local home designer complete the full construction plans for you or we can offer you a low cost set of working drawings ready for construction.

Included In this pack:

The Builders Pack is ideal for builders to use in costing homes.

• Concept plan • Concept Elevations • Copyright to use plan • PDF so you of

• PDF so you can print off as many as you want

Custom Changes and Construction Plans

We offer a full custom design service where you can change the initial design or we can create a complete custom design to suit your needs and budget.

Do you want modifications to this design Order our Custom Design Set - See below for more details

CONSTRUCTIONS PLANS OPTION


DO YOU WANT MORE DETAILED PLANS? Buy Our Construction Plans & Copyright Licence Pack


2. Full House Plan Set - \$Free Quote

Full set of construction plans for the home shown in the above images. These are ideal for builders as they are a full set of working drawings. The full house plan set is pre-drawn so no changes to the plan can be made. The Full House Plan Set is a discounted set of plans as the cost of drawing is shared over many buyers. If you want to customise the plan you would then need to choose the Custom Design Set as set out below, and we will make any changes to the plan prior to posting.

Includes:

- Floor plan with all dimensions nominated.
- Elevation Plans
- Electrical Plans
- Bracing Plans
- Tie Down Details
- Building Notes Page
- Sketch Plan
- 3D Render of Façade
- All the above plans are classified as "Full Working Drawings"
- A site plan can be provided if required .

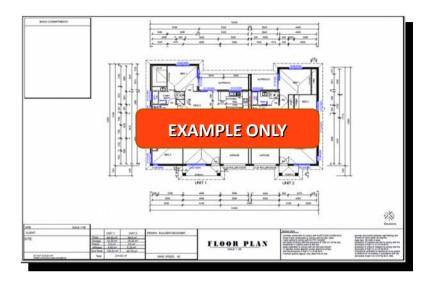

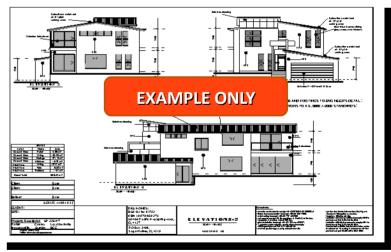

Do you want modifications to this design
Order our Custom Design Set - See below for more details

CUSTOM DESIGN OPTION

Do you want modifications to this design


3. Custom Design Set – Free Quote


A Custom Design Set is a full set of construction plans as per the Full House Plan Set, however we also will make custom changes as per your requirements. When you request a change to a plan, example room sizes, window changes, layout changes etc our Custom Design Team need to redraw all the plans to reflect your changes. This is very labour intensive and time consuming as creating a full set of working drawings with roof changes and bracing changes can take 5-7 days labour. Even a small change like a window change will still need all the plans to be altered. However our discounted Custom Design Set is dramatically cheaper than most Design Companies

Includes: (Customised to your requirements)

- Floor plan with all dimensions nominated.
 - Elevation Plans
 - Electrical Plans
 - Bracing Plans
 - Tie Down Details
 - Building Notes Page
 - Sketch Plan
 - 3D Render of Façade
- All the above plans are classified as "Full Working Drawings"
- A site plan can be provided if required for a cost of \$250.00.
- Please contact us with any questions for Custom Design Set and we will call you back to discuss it further

admin@australianfloorplans.com

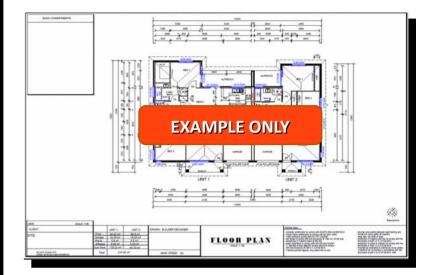

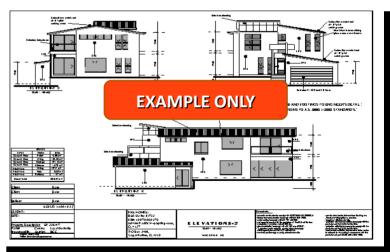

DRAFTING CH DATE:/_		Australainfloo	rplans.com					<u>Custom Changes</u>
Client:	Dwg#							Custom changes are easy. Just fill
Address:								in this form and fax it to us. If you have a rough sketch you can send that as well.
Phone No:		Mobile	≥ No:					
RP or SP#:			louse Design:					
Please Circle req	uıred			Please Circle r	equired			We will quote the changes and
Floor		Timber Elevated	floor	Garage	Single	Double		email it to you.
Roof Pitch	20 deg	22.5 dea	25 deg	Local Council is				T
Roof Material		Metal roof	J	Land				You can email the form to
Ceiling Height	2440mm	2550mm	2740mm	Slope of Land - Looking from street				
No of bedrooms	2 3	4 5		Falls left to right				admin@australianfloorplans.com
Other rooms rea	Lounge	Home Cinema	Family	Falls right to lef				
Water	Town wate	Water Tank		Rise from the road			Or	
Cladding	Brick	Hardıplank	Render	Falls from the road			5 07 22400046	
Hot Water	Gas	Electric Heating	Solar Heating	Notes: To have	a Land sui	vey is bes	t	Fax: 07 33190916
Bracing (if known)	N2	N3 N4	CI C2	Frame		T		
House levels	Single	Double	3 storey	Wall & Roof Frame	Timber	Steel	Block	
	Ĭ		Í					
Toilet	Sewer	Treatment Plant						
Other Notes: Please advise if you	require spec	ıal sızes for the roo	ms otherwise we wil	ll use STD rooms sizes				

Email or fax to Australian floor plans Fax: 07 33190916 - Email:admin@australianfloorplans.com



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